LEGAL DESCRIPTION:

Lot 13 Plan EPP64961 Section 14 Township 23 Land District 41

030-104-157 CD15 - Airport Business Park

LANDSCAPE AREA CALCULATION:

TOTAL SITE AREA: 3998.3 M2 LANDSCAPED AREA ON SITE: 1,497.18 M2 (37%)

LANDSCAPED AREA ON SITE: 1,497.18 M2 (37%)
LANDSCAPED AREA OFF SITE (BOULEVARDS): 516.7 M2



PROPOSED PROJECT AREA

GENERAL NOTES:
I. ALL LANDSCAPING TO CONFORM TO THE LATEST EDITION OF THE 'CANADIAN LANDSCAPE STANDARD' UNLESS OTHERWISE NOTED HEREIN.

2. ALL LANDSCAPE PLANTINGS SHALL HAVE UNDERGROUND IRRIGATION INSTALLED, UNLESS NOTED. THE CONTRACTOR IS RESPONSIBLE FOR PREPARING SHOP DRAWINGS FOR IRRIGATION SYSTEM DESIGN, REFER TO SPECIFICATIONS. CONTRACTOR TO PROVIDE SHOP DRAWINGS TO THE LANDSCAPE ARCHITECT FOR APPROVAL PRIOR TO INSTALLATION.


3. THE CONTRACTOR TO LOCATE AND MARK ALL UNDERGROUND SERVICES THAT MAY BE AFFECTED BY THE WORK AND REPAIR ALL DAMAGES TO EXISTING CONDITION.


4. LANDSCAPE GRADING SHALL CONFORM TO THE SITE GRADING AND DRAINAGE PLAN PREPARED BY OTHERS, UNLESS OTHERWISE DETERMINED ON SITE BY THE ARCHITECT AND/


5. THIS PLAN IS PREPARED FOR PERMIT APPLICATION ONLY AND SHALL NOT BE USED FOR CONSTRUCTION UNLESS APPROVED IN WRITING BY LIMINAL DESIGN.

6. THE CONTRACTOR SHALL NOTIFY THE ARCHITECT PRIOR TO ANY LANDSCAPE CONSTRUCTION. THE CONTRACTOR IS RESPONSIBLE FOR ENSURING THAT THEY HAVE THE COMPLETE AND MOST RECENT LANDSCAPE DOCUMENTS. THE DOCUMENTS SHALL BE COMPLETE, CURRENT AND PRINTED TO SCALE.

7. ANY NATURAL LANDSCAPING THAT IS DISTURBED BY CONSTRUCTION MUST BE RESEEDED WITH DRYLAND GRASS SPECIES FOR RESTORATION TO EXISTING CONDITIONS.

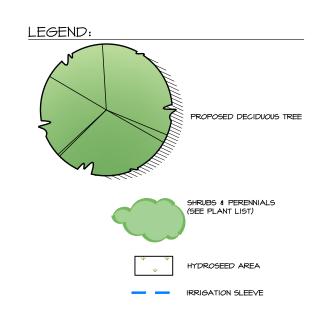

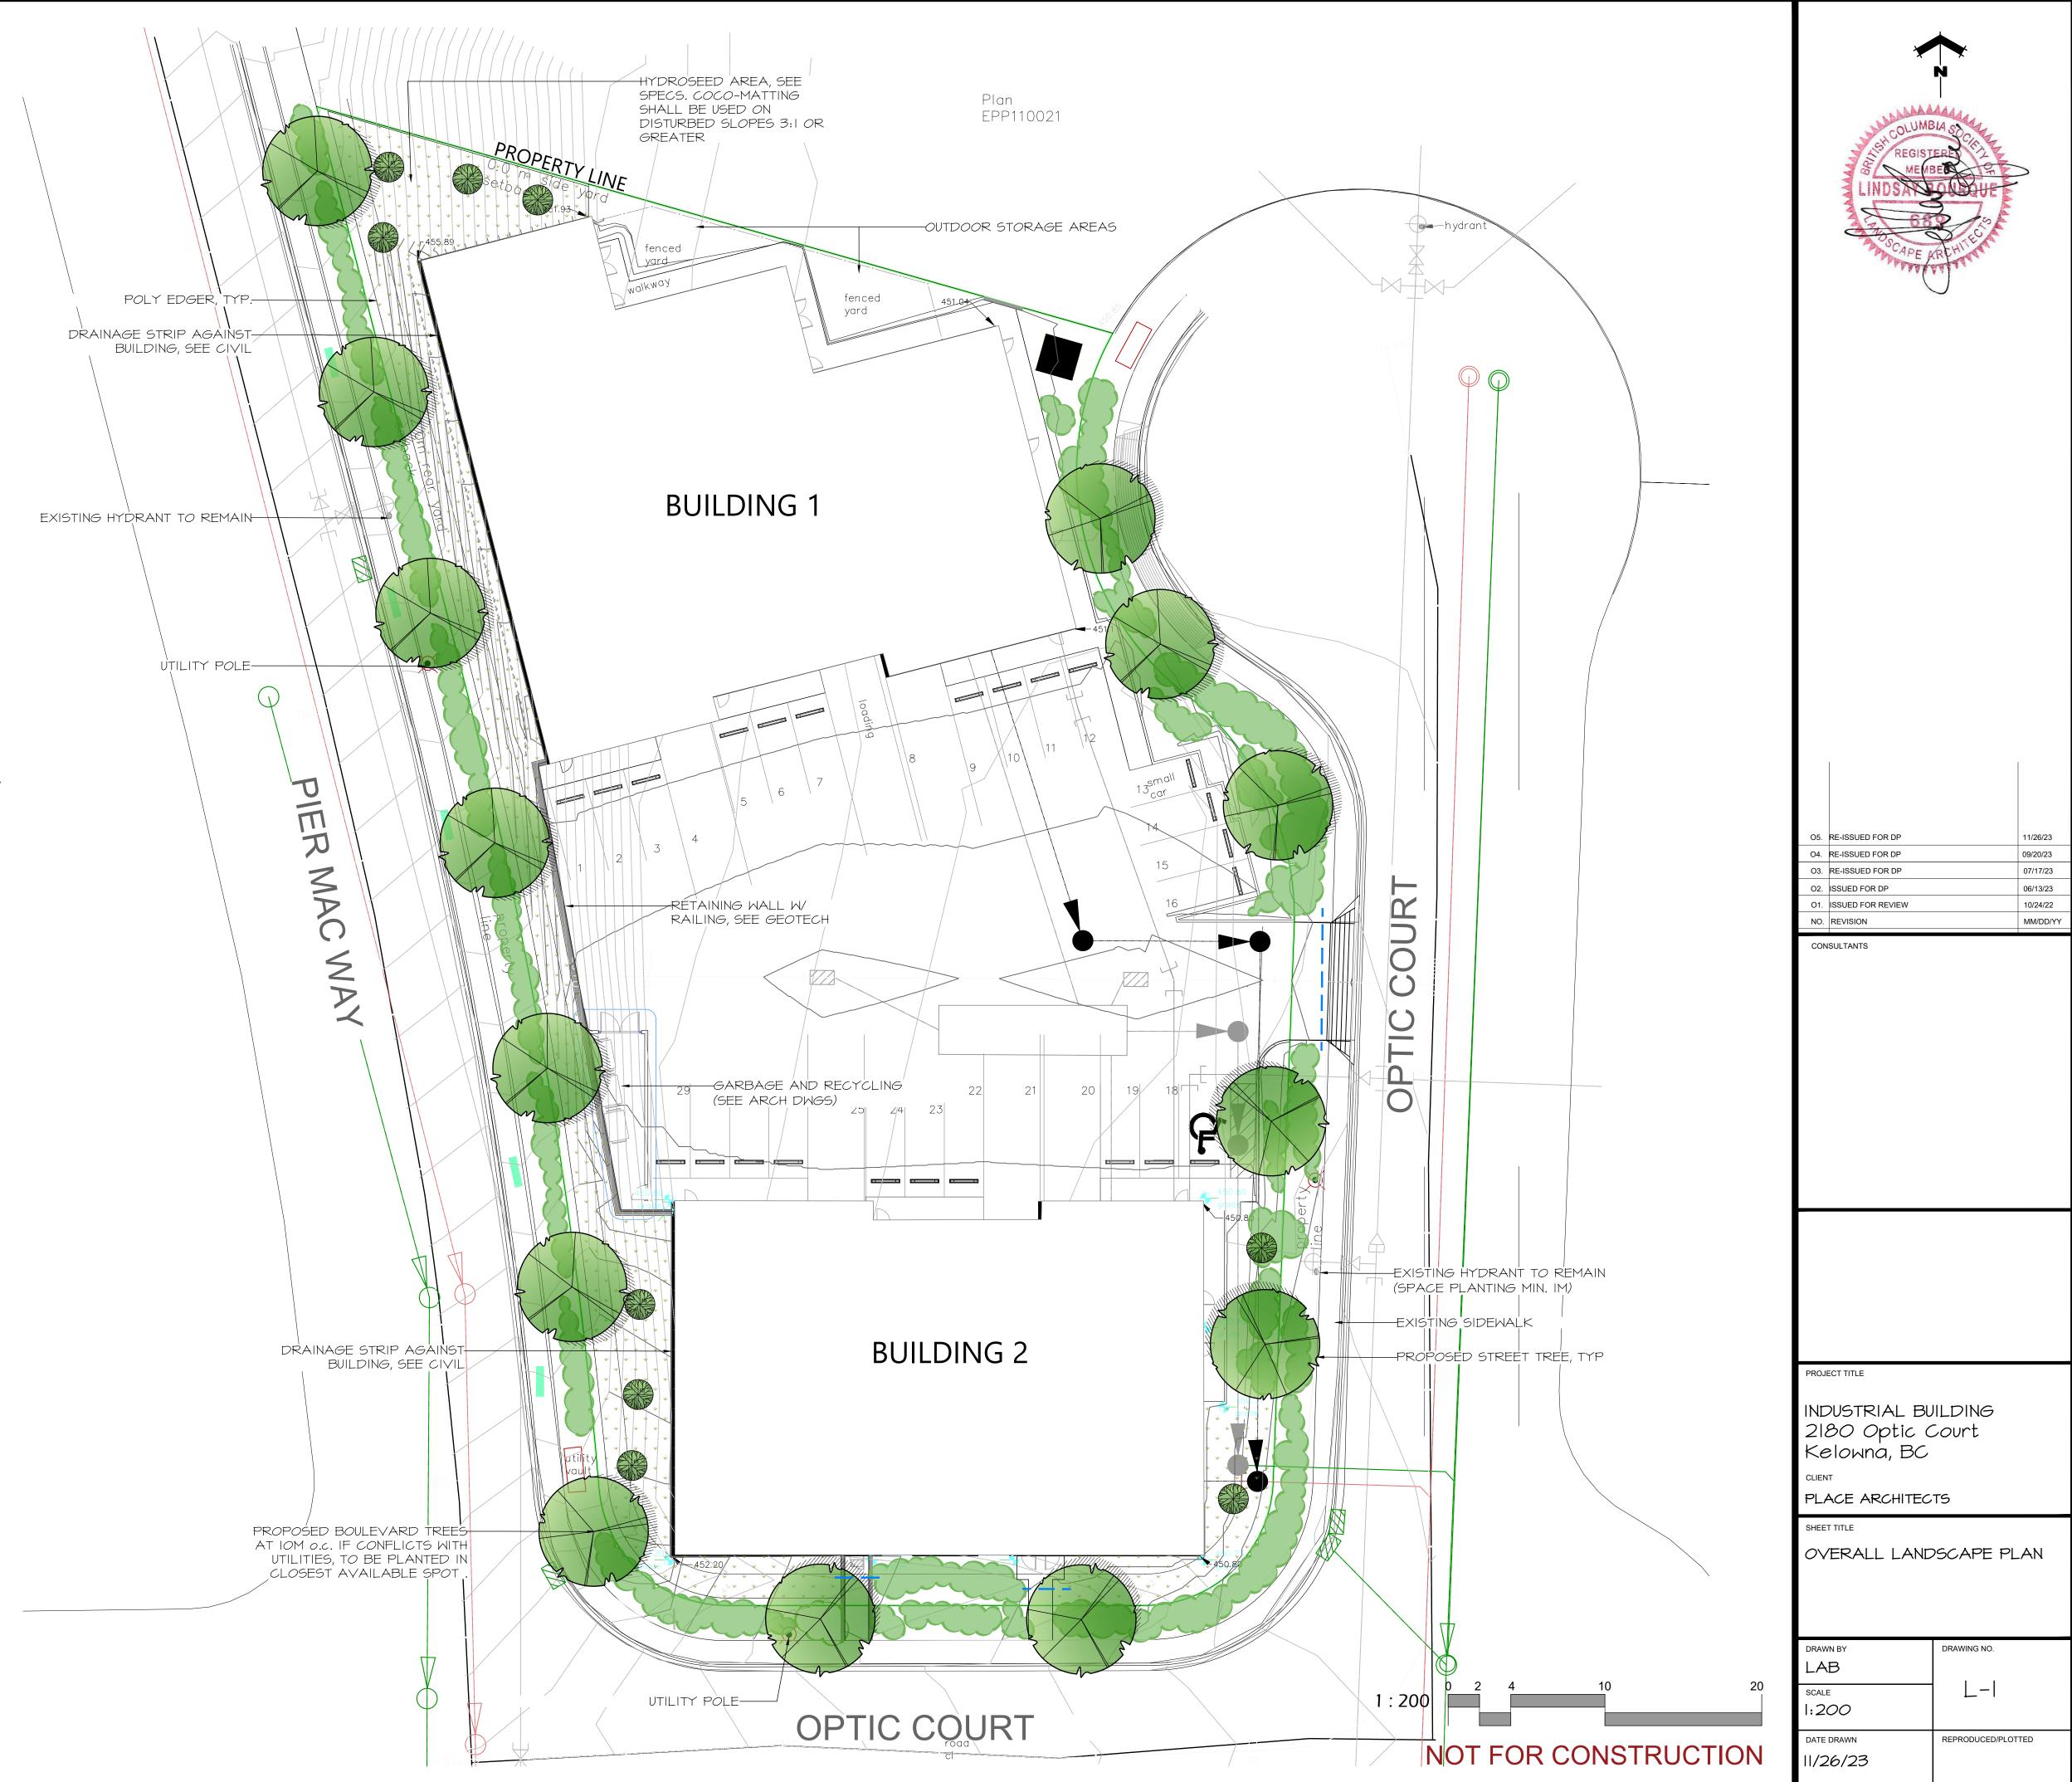

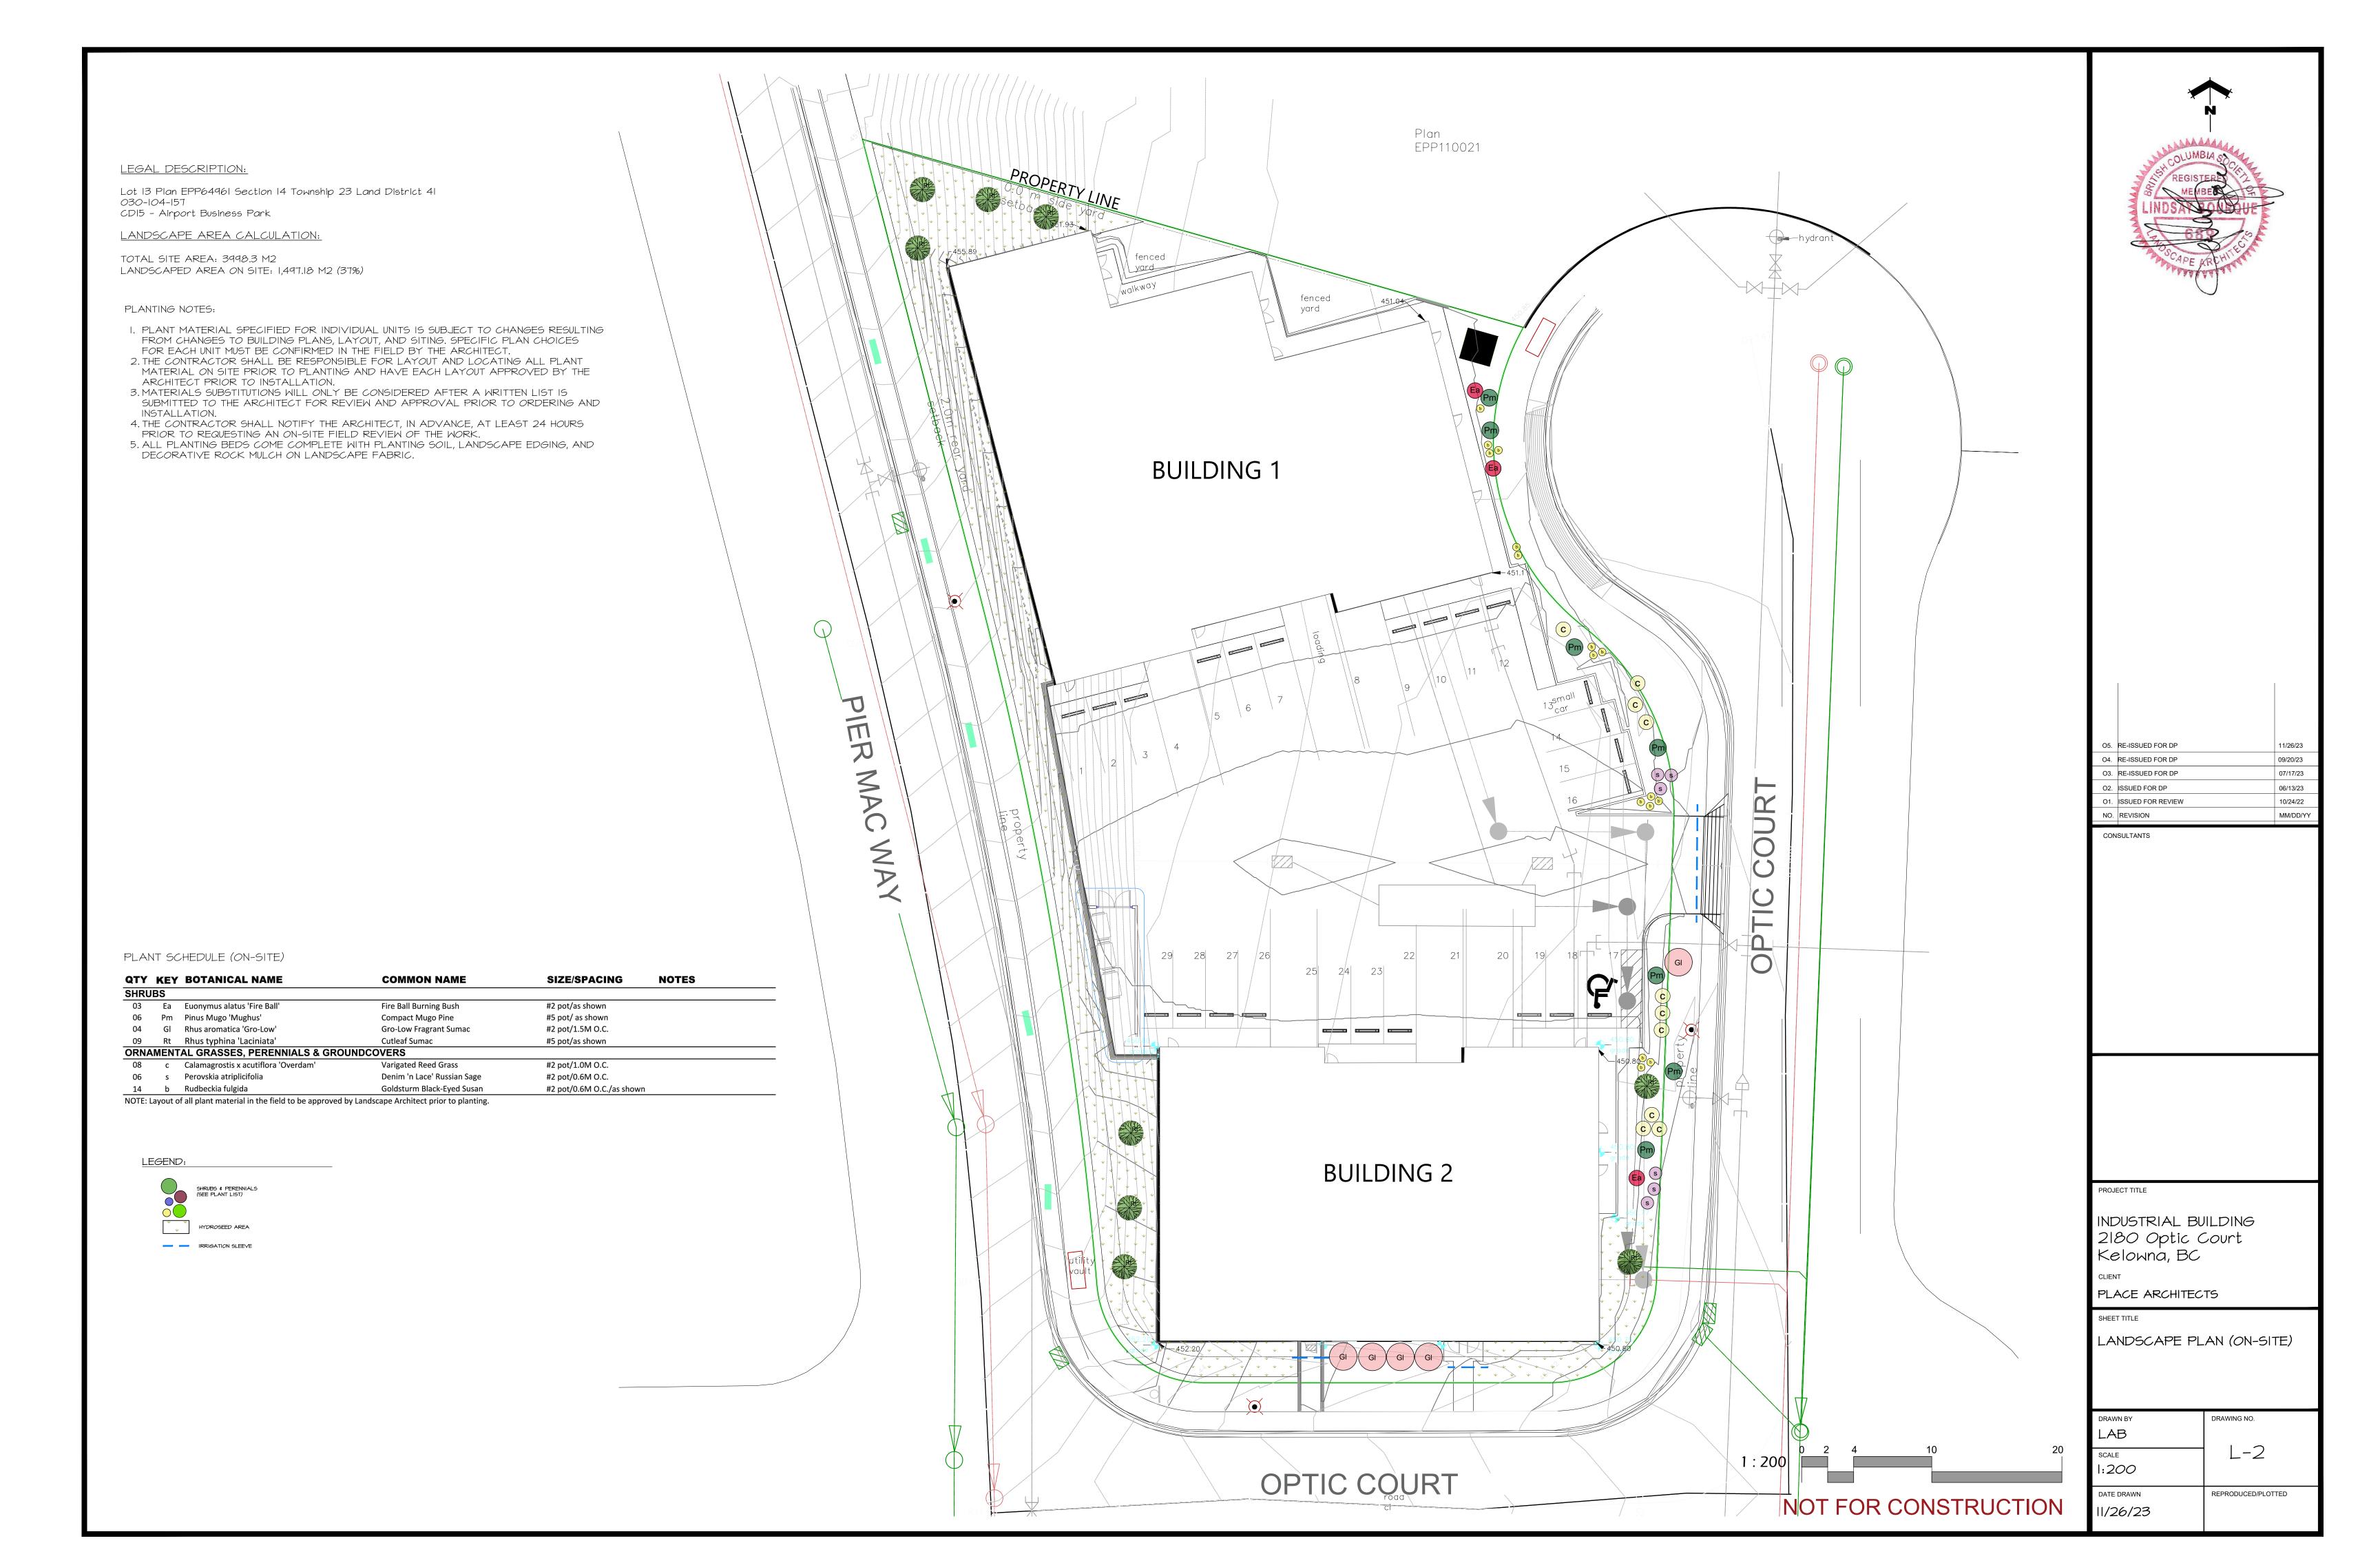



Lot 13 Plan EPP64961 Section 14 Township 23 Land District 41 030-104-157

CD15 – Airport Business Park

LANDSCAPE AREA CALCULATION:

TOTAL SITE AREA: 3998.3 M2 LANDSCAPED AREA OFF SITE (BOULEVARDS): 516.7 M2


PLANTING NOTES:


- I. PLANT MATERIAL SPECIFIED FOR INDIVIDUAL UNITS IS SUBJECT TO CHANGES RESULTING FROM CHANGES TO BUILDING PLANS, LAYOUT, AND SITING. SPECIFIC PLAN CHOICES FOR EACH UNIT MUST BE CONFIRMED IN THE FIELD BY THE
- 2. THE CONTRACTOR SHALL BE RESPONSIBLE FOR LAYOUT AND LOCATING ALL PLANT MATERIAL ON SITE PRIOR TO PLANTING AND HAVE EACH LAYOUT APPROVED BY THE ARCHITECT PRIOR TO INSTALLATION.
- 3. MATERIALS SUBSTITUTIONS WILL ONLY BE CONSIDERED AFTER A WRITTEN LIST IS SUBMITTED TO THE ARCHITECT FOR REVIEW AND APPROVAL PRIOR TO ORDERING AND INSTALLATION.
- 4. THE CONTRACTOR SHALL NOTIFY THE ARCHITECT, IN ADVANCE, AT LEAST 24 HOURS PRIOR TO REQUESTING AN ON-SITE FIELD REVIEW OF THE WORK.


 5. ALL PLANTING BEDS COME COMPLETE WITH PLANTING SOIL, LANDSCAPE EDGING, AND DECORATIVE ROCK MULCH ON LANDSCAPE FABRIC.


PLANT SCHEDULE			Jg	29 28 27 26	22 21 20	19 18 GI	10
QTY KEY BOTANICAL NAME	COMMON NAME	SIZE/SPACING NOTES	Jg Jg		25 24 23		
TREES							
14 TC Tilia cordata	Littleleaf linden	50mm cal/ 10M o.c	39				
SHRUBS							
01 Ea Euonymus alatus 'Fire Ball'	Fire Ball Burning Bush	#2 pot/as shown					
76 Jg Juniperus chinensis 'Sea Green'	Sea Green Juniper	#2 pot/2.0M O.C.		(450)89		450.80	
01 Pm Pinus Mugo 'Mughus'	Compact Mugo Pine	#5 pot/ as shown	\ \ \ \ \ \ \ \ \ \ \ \ \ \ \ \ \ \ \			9000	
02 Gl Rhus aromatica 'Gro-Low'	Gro-Low Fragrant Sumac	#2 pot/1.5M O.C.				450.80	
RNAMENTAL GRASSES, PERENNIALS & GR	OUNDCOVERS		1 Total III				
12 c Calamagrostis x acutiflora 'Overdam'	Varigated Reed Grass	#2 pot/1.0M O.C.					
19 s Perovskia atriplicifolia	Denim 'n Lace' Russian Sage	#2 pot/0.6M O.C.	Jg TC				
08 b Rudbeckia fulgida NOTE: Layout of all plant material in the field to be approve	Goldsturm Black-Eyed Susan	#2 pot/0.6M O.C./as shown					
			Jg Jg		BUILDING 2	Jg Jg Jg Jg Jg	
			Jg	452:20	grobe grade	Jg J	
				Jg Jg Jg Jg S S S	S Jg Jg S S S S S S S S S S S S S S S S	Jg Jg Jg Jg	

PROPERTY LINE Sectorics Sectori	REGISTERIO MEMBER SALINDSAN SOLAPE ARCHITECT
BUILDING 1	
LWOOD DILAO	O5. RE-ISSUED FOR DP 11/26/23 O4. RE-ISSUED FOR DP 09/20/23 O3. RE-ISSUED FOR DP 07/17/23 O2. ISSUED FOR DP 06/13/23 O1. ISSUED FOR REVIEW 10/24/22 NO. REVISION MM/DD/YY CONSULTANTS
BUILDING 2	PROJECT TITLE INDUSTRIAL BUILDING 2180 Optic Court Kelowna, BC CLIENT PLACE ARCHITECTS SHEET TITLE LANDSCAPE PLAN (OFF-SITE) DRAWN BY DRAWING NO.
OPTIC COURT NOT FOR CONSTRUCTION	LAB SCALE 1:200 DATE DRAWN 11/26/23 REPRODUCED/PLOTTED

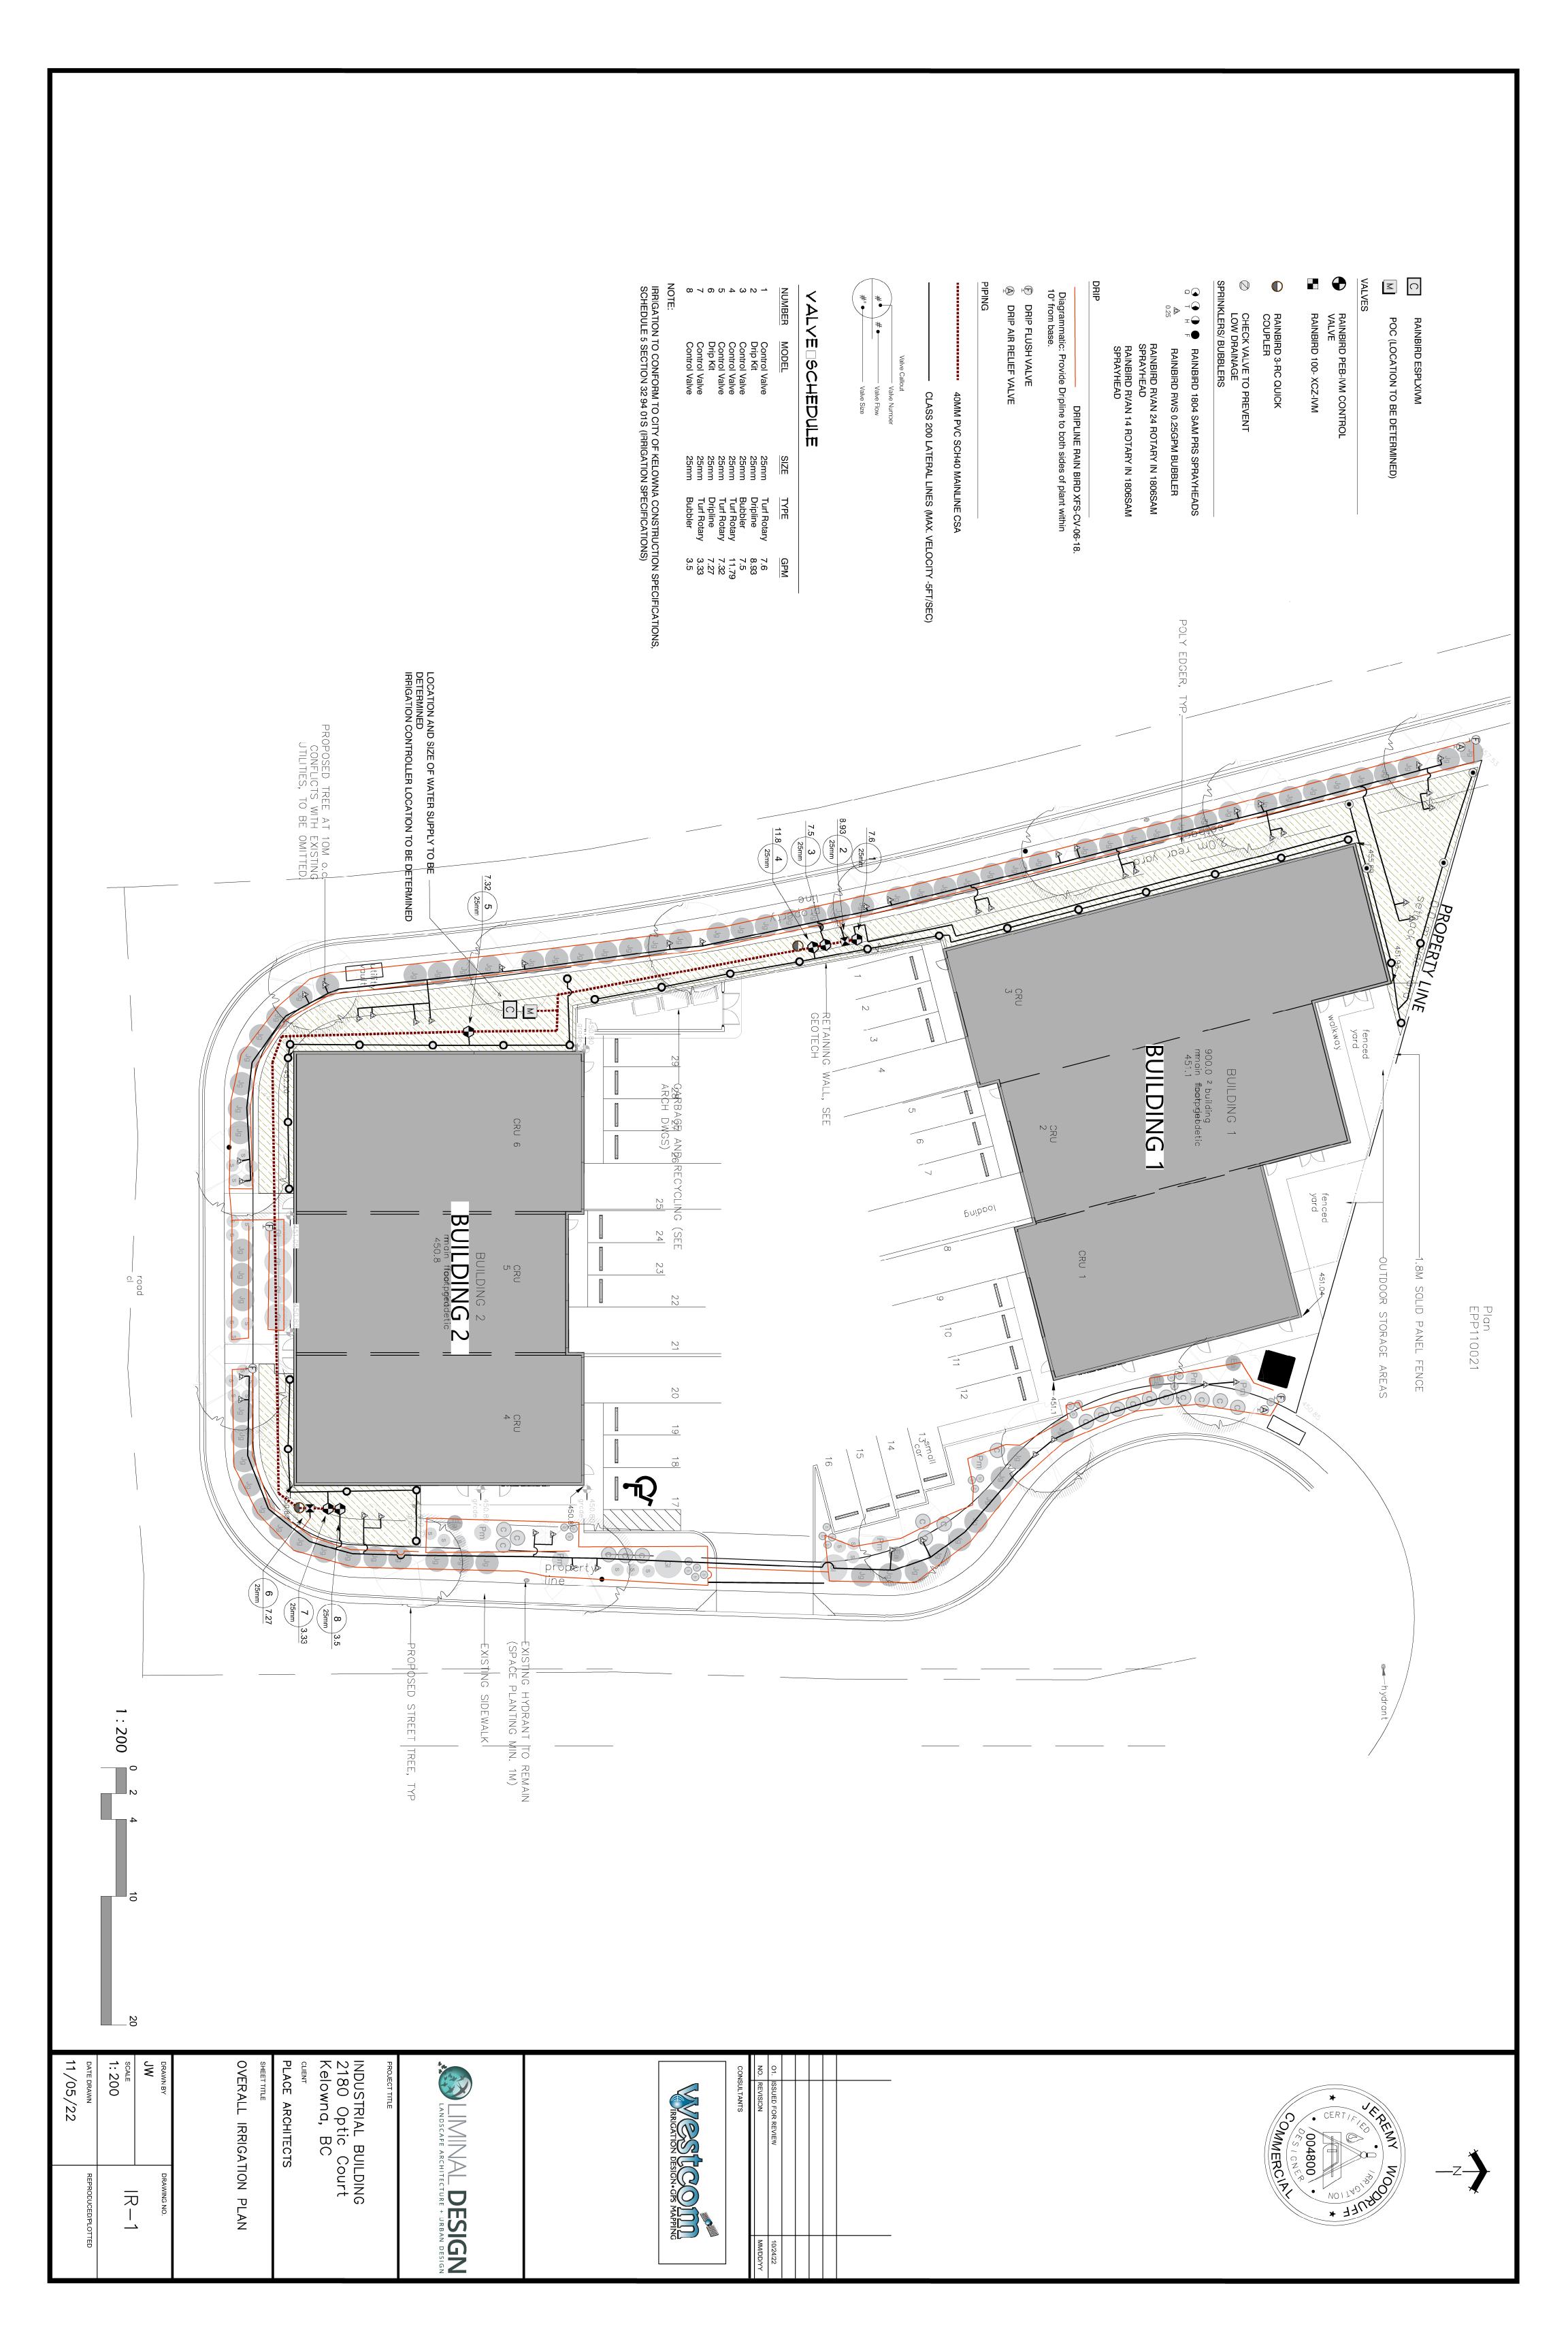

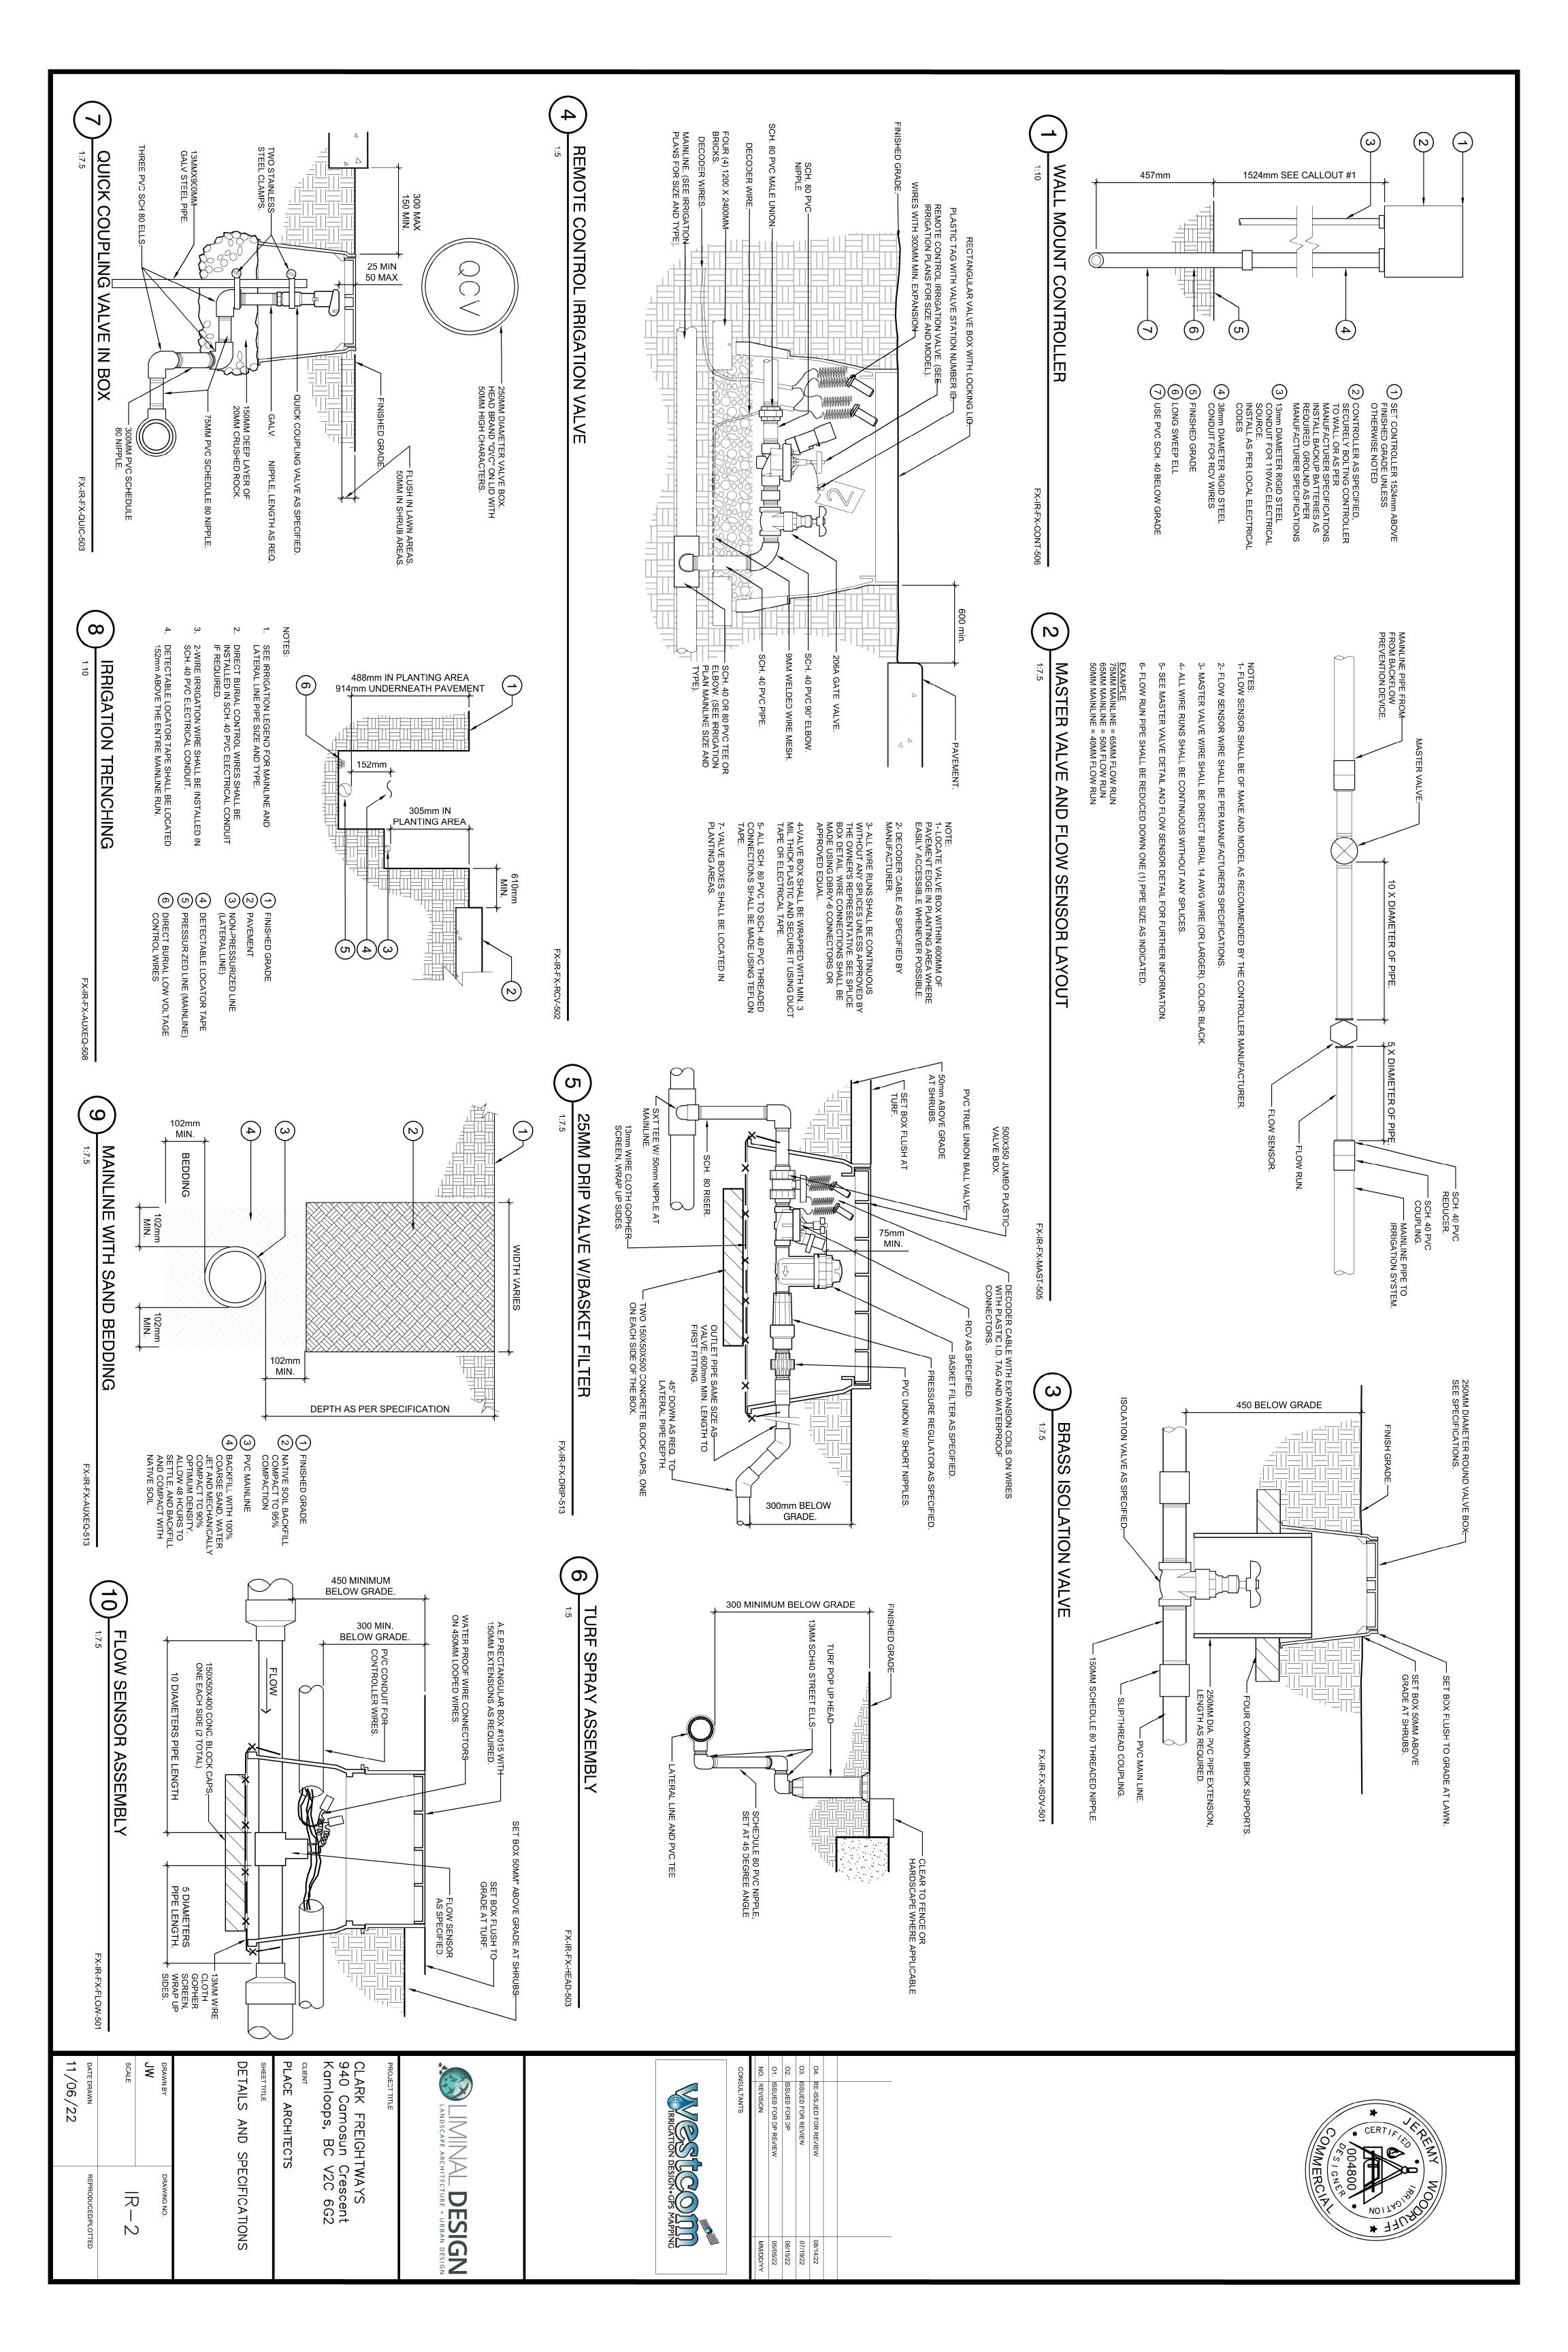


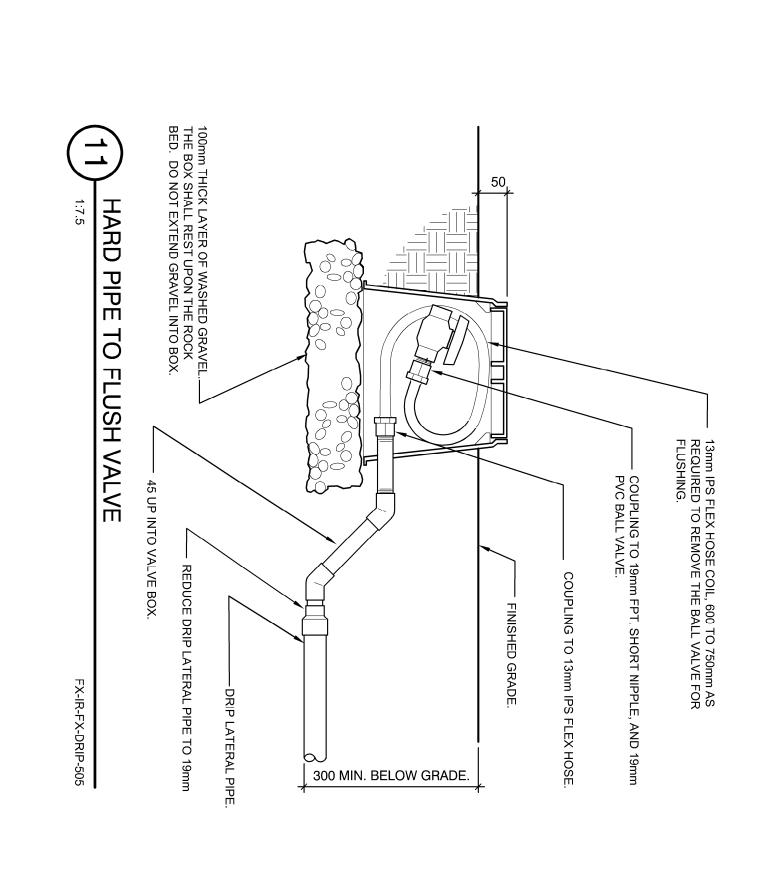

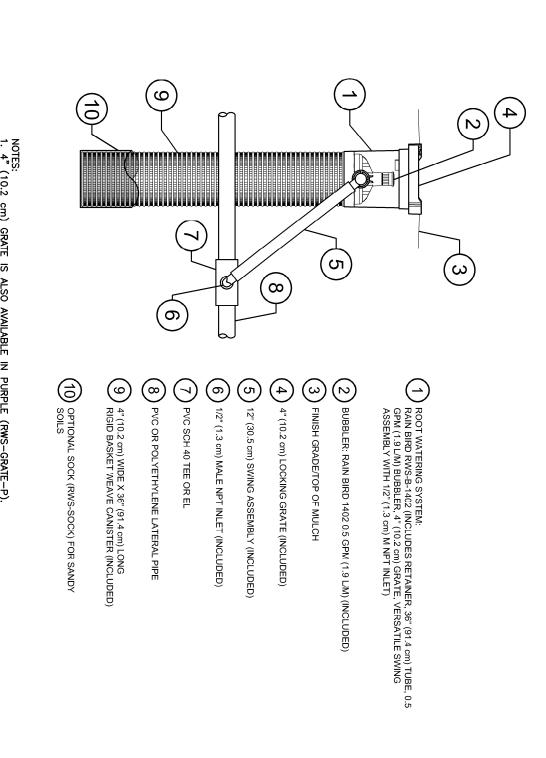



FX-IR-FX-HEAD-502

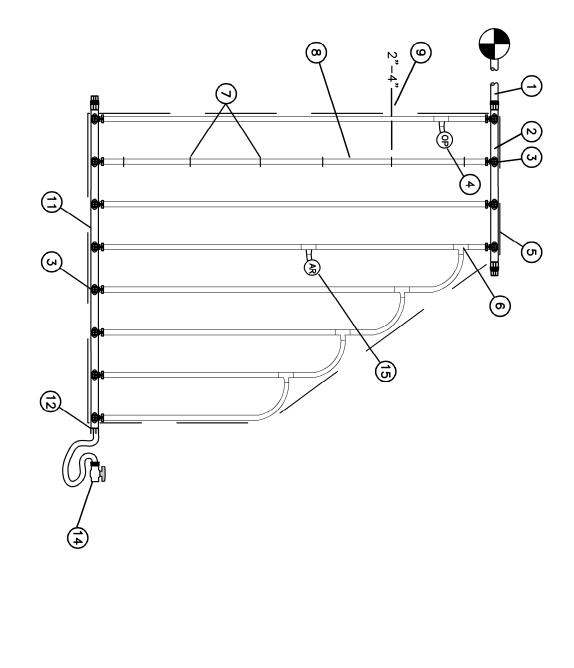

(1)POLYETHYLENE OR PVC SUPPLY PIPE FROM RAIN BIRD CONTROL ZONE KIT (SIZED TO MEET LATERAL FLOW DEMAND)

(2) QF SUPPLY HEADER
(3) PRE-INSTALLED BARB FITTING
(4) OPERATION INDICATOR
RAIN BIRD MODEL: OPERIND 7) XF SERIES TIE-DOWN STAKES (TDS-050)
REFER TO RAIN BIRD DRIPLINE DESIGN GUIDE
FOR PROPER SPACING (6) BARB X BARB INSERT TEE:
RAIN BIRD XFF-TEE (TYPICAL) (5) PERIMETER OF AREA

(1) QF EXHAUST HEADER
(12) TWIST LOCK FITTING: TLF-MPT OR INSERT FITTING WITH OETIKER (10) FLUSH POINT (TYPICAL)
SEE RAIN BIRD DETAIL "XFS-CV FLUSH POINT" PERIMETER DRIPLINE PIPE TO BE INSTALLED 2"-4" FROM PERIMETER OF AREA


(8) SUB-SURFACE/ON-SURFACE DRIPLINE:
RAIN BIRD XFS-CV SERIES DRIPLINE (TYPICAL)
NON-POTABLE: XFS-CVP DRIPLINE

(14) PVC SCH 40 BALL VALVE (15) AIR / VACUUM RELIEF VALVE (15) DRIP AREA) (13) TWIST LOCK CAP: TLF-CAP OR INSERT FITTING C/W OETIKER AND THREADED CAP (AT HIGH POINT OF

 $\frac{1}{3}$

XFS-CV

DRIP-LINE-MANIFOLD

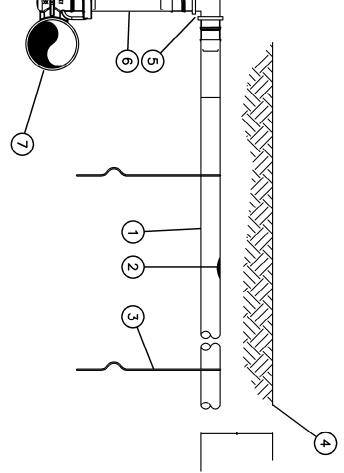


NOTES:

1. PLACE TIE DOWN STAKES EVERY THREE FEET IN SAND, FOUR FEET IN LOAM, AND FIVE FEET IN CLAY.

2. AT FITTINGS WHERE THERE IS A CHANGE OF DIRECTION SUCH AS TEES OR ELBOWS, USE TIE—DOWN STAKES ON EACH LEG OF THE CHANGE OF DIRECTION.

3. BURYING HEADER AT 200MM HELPS DECREASE CHANCE OF DRIP—LINES MOVING TO SURFACE BUT LOOSE SOIL CONDITIONS OR LACK OF STAKING CAN STILL RESULT IN EXPOSED DRIP—LINES WHEN INSTALLED WITHOUT FABRIC AND OR ROCK MULCH COVERING.

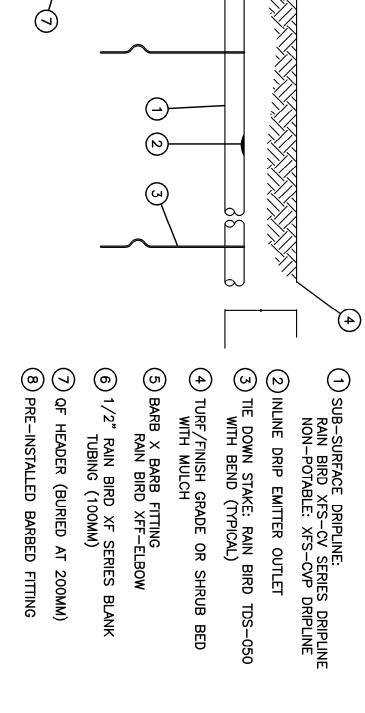

LANDSCAPE ARCHITECTURE + URBAN DESIGN

WESTCOMMINION DESIGN-GPS MAPPING

CLARK FREIGHTWAYS 940 Camosun Crescent Kamloops, BC V2C 6G2 PLACE ARCHITECTS

DETAILS AND SPECIFICATIONS

11/06/22

DRAWN BY 刀 \sim